

ABBRE\	/IATIONS:
А	AMPS
AASHTO	AMERICAN ASSOCIATION OF STATE HIGHWAY AND TRANSPORTATION OFFICIALS
AC	AIR CONDITIONING [UNIT]
AFF	ABOVE FINISH FLOOR
AFG AL. ALUM.	ABOVE FINISH GRADE ALUMINUM
AHJ	AUTHORITY HAVING JURISDICTION
ANSI ASTM	AMERICAN NATIONAL STANDARDS INSTITUTE AMERICAN SOCIETY FOR TESTING AND MATERI
ASTM	AUTOMATIC TRANSFER SWITCH
AVI	AUTOMATIC VEHICLE IDENTIFICATION
AWG BCU	AMERICAN WIRE GAUGE BATTERY CHARGER UNIT
BLDG.	BUILDING
BPS	BYPASS SWITCH
BTUH C.	BRITISH THERMAL UNIT PER HOUR CONDUIT
CCTV	CLOSED CIRCUIT TELEVISION
CKT. COMP	CIRCUIT COMPUTER
CU	COPPER
COMM.	COMMUNICATION
DEP DIA.	DEPARTMENT OF ENVIRONMENTAL PROTECTION DIAMETER
DISC. SW.	
DN DWG.	DOWN DRAWING
E6	ENCOMPASS 6 MULTIPROTOCOL READER
EB	EASTBOUND
ENG. EOR	ENGINE ENGINEER OF RECORD
ETC	ELECTRONIC TOLL COLLECTION
ETC.	ET CETERA
EQUIP. EPA	EQUIPMENT ENVIRONMENTAL PROTECTION AGENCY
EPO	EMERGENCY POWER OFF
EXT. FBC	EXTERIOR FLORIDA BUILDING CODE
FLA	FULL LOAD AMPS
FOC	FIBER OPTIC CABLE
FT FTL	FOOT; FEET FEED THROUGH LUGS
FTM	FUEL TANK MONITOR
FUT GA	FUTURE GAUGE
GAL.	GALLON
GCB	GENERATOR CIRCUIT BREAKER
GEC GEN	GROUNDING ELECTRODE CONDUCTOR GENERATOR
GFI	GROUND FAULT INTERRUPTER
GND GPTL	GROUND GENERAL PURPOSE TOLLING LANE
HP	HORSEPOWER
I.C.	INTERRUPTING CAPACITY
I.D. IN.	IDENTIFICATION INCHES
IPB	INTERMEDIATE PULLBOX
ITS JB	INTELLIGENT TRANSPORTATION SYSTEM JUNCTION BOX
KA	KILOAMPERES
KVA	KILOVOLT AMPERES
KW LED	KILOWATT LIGHT EMITTING DIODE
LFMC	LIQUID TIGHT FLEXIBLE METAL CONDUIT
LN CTR LOC.	LANE CONTROLLER LOCATION
LP	LIGHTNING PROTECTION
LPG	LIQUID PROPANE GAS
LTG MAX.	LIGHTING MAXIMUM
MCB	MAIN CIRCUIT BREAKER
MTS MIN.	MANUAL TRANSFER SWITCH MINIMUM
ML.	MAINLINE
M.L.O.	MAIN LUGS ONLY
MOT MPB	MAINTENANCE OF TRAFFIC MEDIAN PULLBOX
MTD	MOUNTED

RIALS	NEC	NEUTRAL NORTHBOUND NORMALLY CLOSED NATIONAL ELECTRICAL CODE NATIONAL ELECTRICAL MANUFACTURERS ASSOCIATION NOT IN CONTRACT NUMBER NORMALLY OPEN NOMINAL PIPE SIZE NOTICE TO PROCEED NOT TO SCALE NEMA 3R
DN .	RGS RMS SB SCADA SCH. SCP SCTE SER SPD SPEC(S) S.P.S.T. S.S. STP SQ. SYMM. T.E.C./TEC	RIGID GALVANIZED STEEL ROOT MEAN SQUARED SOUTHBOUND SUPERVISORY CONTROL & DATA ACQUISITION SCHEDULE SCADA CONTROL PANEL SOCIETY OF CABLE TELECOMMUNICATIONS ENGINEERS

ABBREVIATIONS CONT:

		REVISIONS			
DATE	DESCRIPTION	DATE	DESCRIPTION	AECOM Technical Services, Inc.	
				7650 West Courtney Campbell Causeway Tampa, FL 33607-1462	ROAD NO.
			C.A. No. 8115 Pete Pastore, P.E. No. 77103	SR 600 SR 618	

MOUNTED

MTD


ELECTRICAL GENERAL NOTES:

- 1. FEED ALL RECEPTACLES AND DEVICES WITH (2) #12, (1) #12 GND IN 3/4" C, UON.
- 2. PROVIDE AN EQUIPMENT GROUNDING CONDUCTOR IN ALL FEEDER AND BRANCH CIRCUIT RACEWAYS.
- 3. ALL 120V, 20A CIRCUIT HOMERUNS OVER 50FT. SHALL BE #10 CU MINIMUM,
- 4. ALL 120V, 20A CIRCUIT HOMERUNS OVER 150FT. SHALL BE #8 CU MINIMUM, UON.
- 5. ALL 240V, 20A CIRCUIT HOMERUNS OVER 150FT. SHALL BE #10 CU. MINIMUM, UON.
- 6. ALL 240V, 20A CIRCUIT HOMERUNS OVER 300FT. SHALL BE #8 CU MINIMUM, UON.
- 7. VERIFY EXACT LOCATION OF ALL MECHANICAL EQUIPMENT WITH MECHANICAL INSTALLER PRIOR TO ROUGH—IN.
- 8. PROVIDE PULL STRINGS IN ALL EMPTY CONDUIT AND RACEWAYS WITH LABELING AT EACH END.
- 9. THE USE OF ANY PROCESS INVOLVING ASBESTOS OR PCB, AND THE INSTALLATION OF ANY PRODUCT, INSULATION, COMPOUND OR MATERIAL CONTAINING OR INCORPORATING ASBESTOS OR PCB, IS PROHIBITED. PROVIDE A COMPLETE AND PROPERLY OPERATING ELECTRICAL SYSTEM WITHOUT THE USE OF ASBESTOS OR PCB
- 10. THE ELECTRICAL CONTRACTOR SHALL CONTACT THE POWER COMPANY WITHIN 10 BUSINESS DAYS OF THE NOTICE TO PROCEED AND SCHEDULE NEW SERVICE INSTALLATION.
- 11. REFER TO TECHNICAL SPECIAL PROVISIONS FOR ADDITIONAL REQUIREMENTS.
- 12. INCLUDE THE TRANSPORT AND DISPOSAL OR RECYCLING OF ALL WASTE MATERIALS GENERATED BY THIS PROJECT IN ACCORDANCE WITH ALL RULES, REGULATIONS AND GUIDELINES APPLICABLE.
- A) COMPLY FULLY WITH FLORIDA STATUTE 403.7186 REGARDING MERCURY CONTAINING DEVICES AND LAMPS.
- B) TRANSPORT AND DISPOSE OF LAMPS, BALLASTS AND OTHER MATERIALS IN ACCORDANCE WITH ALL DEP AND EPA GUIDELINES.
- C) PROVIDE WRITTEN CERTIFICATION THAT ALL MATERIALS WERE RECYCLED OR DISPOSED OF PROPERLY PER THE GUIDELINES NOTED ABOVE.
- 13. LOCATE EXISTING UTILITIES AND PROTECT THEM FROM DAMAGE. THE LOCATIONS OF EXISTING AND PROPOSED UTILITIES, AS SHOWN ON THESE PLANS, ARE APPROXIMATE AND BASED ON THE INFORMATION FURNISHED TO THE ENGINEER BY THE UTILITY OWNER(S) AND ARE SHOWN AS NOTICE TO THE CONTRACTOR THAT UNDERGROUND UTILITIES EXIST. BEFORE EXCAVATING, NOTIFY THE SERVING UTILITY COMPANY(S) AND REQUEST THEM TO LOCATE AND STAKE THEIR UNDERGROUND FACILITIES. UTILITIES ARE TO BE ADJUSTED BY OTHERS AS DIRECTED BY THE FNGINFFR.
- 14. PHASE WORK AS REQUIRED BY MOT PLANS.
- 15. UNDERGROUND CONDUIT SHALL BE PVC SCH. 80, UON. UNDERGROUND CONDUIT SHALL TRANSITION TO RGS CONDUIT WITH PVC TO RGS CONDUIT FITTINGS. CONDUIT SHALL BE RGS ABOVE GRADE THROUGH AND INCLUDING THE FIRST 90 DEGREE FITTING UNDERGROUND UON. APPLY (2—COATS) BITUMASTIC COATING TO DIRECT BURIED PORTION OF RGS CONDUIT, UP TO AND INCLUDING 6" ABOVE FINAL GRADE. REFER TO TSP FOR FURTHER INFORMATION.


- 16. TOLL EQUIPMENT AND ALL WIRING/CABLING FOR TOLL EQUIPMENT WILL BE FURNISHED AND INSTALLED BY T.F.C., UON.
- 17. UNDERGROUND CONDUITS SHALL BE INSTALLED A MINIMUM OF 36" BELOW GRADE.
- 18. EXPOSED EXTERIOR CONDUIT SHALL BE RGS THROUGH AND INCLUDING THE FIRST 90° BEND INSTALLED UNDERGROUND. TRANSITIONS BETWEEN RGS AND PVC CONDUIT SHALL BE MADE UNDERGROUND WITH A RGS TO PVC CONDUIT FITTING.
- 19. EQUIPMENT SPECIFIED WITH CATALOG NUMBERS OR PART NUMBERS SHALL NOT BE SUBSTITUTED UNLESS "OR EQUAL" IS INDICATED.
- 20. CONDUIT RESERVED FOR TOLLING LOOPS SHALL BE SCH. 80 PVC.
- 21. PLASTIC END CAPS SHALL BE INSTALLED ON ENDS OF UNISTRUT.
- 22. ALL LIQUID-TIGHT, FLEXIBLE CONDUIT SHALL BE METALLIC.
- 23. ADJUST THE LOCATIONS OF THE SPD'S SUCH THAT THE MAXIMUM SPD BRAIDED/TWISTED LEADS LENGTH DO NOT EXCEED 24 INCHES AND HAVE NO SHARP TURNS.
- 24. AC OR DC ELECTRICAL CIRCUITS OR WIRING THAT OPERATES AT 25 VOLTS OR GREATER SHALL NOT BE INSTALLED AND/OR LOCATED WITHIN 5 FEET OF ANY TRAFFIC DETECTION LOOP OR LOOP PULL BOX.
- 25. ROADWAY LIGHT POLES, CONDUITS AND CONDUCTORS SHALL NOT BE LOCATED WITHIN 5 FEET OF THE TOLLING LOOP PAVEMENT, TOLL SITE INFRASTRUCTURE, AND SIDEWALK SURROUNDING THE TOLLING EQUIPMENT CONTROL CABINET.
- 26. CONDUIT BENDS SHALL NOT EXCEED 270° BETWEEN PULL POINTS.

REVISIONS TAMPA HILLSBOROUGH REF. DWG. NO AECOM Technical Services, Inc. DATE DATE EXPRESSWAY AUTHORITY **ELECTRICAL GENERAL NOTES** SE-002 7650 West Courtney THEA PROJECT NO Campbell Causeway ROAD NO COUNT FDOT FINANCIAL PROJECT Tampa, FL 33607-1462 SHEET NO. O-17-00217 SELMON WEST EXTENSION FROM THE GANDY BRIDGE TO THE SR 600 C.A. No. 8115 HILLSBOROUGH Pete Pastore, P.E. No. 77103 WESTERN TERMINUS OF THE LEE ROY SELMON EXPRESSWAY 439023-1-52-01 SR 618


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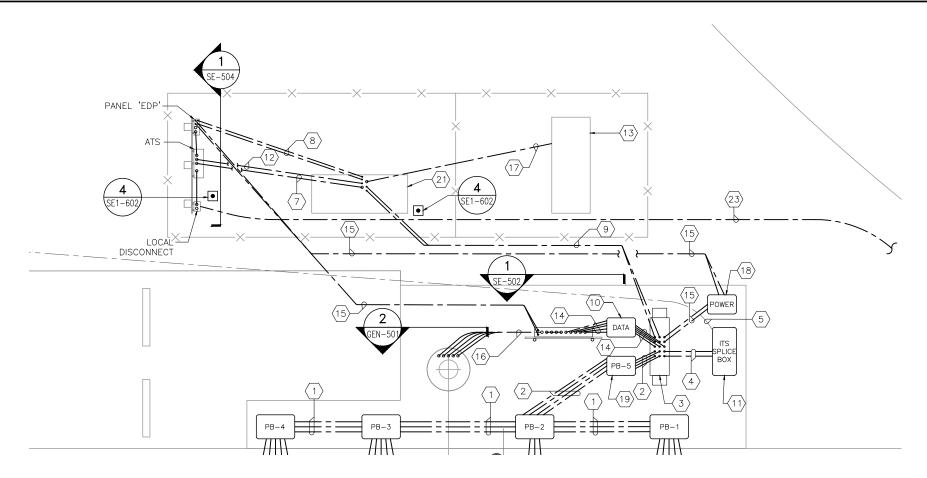


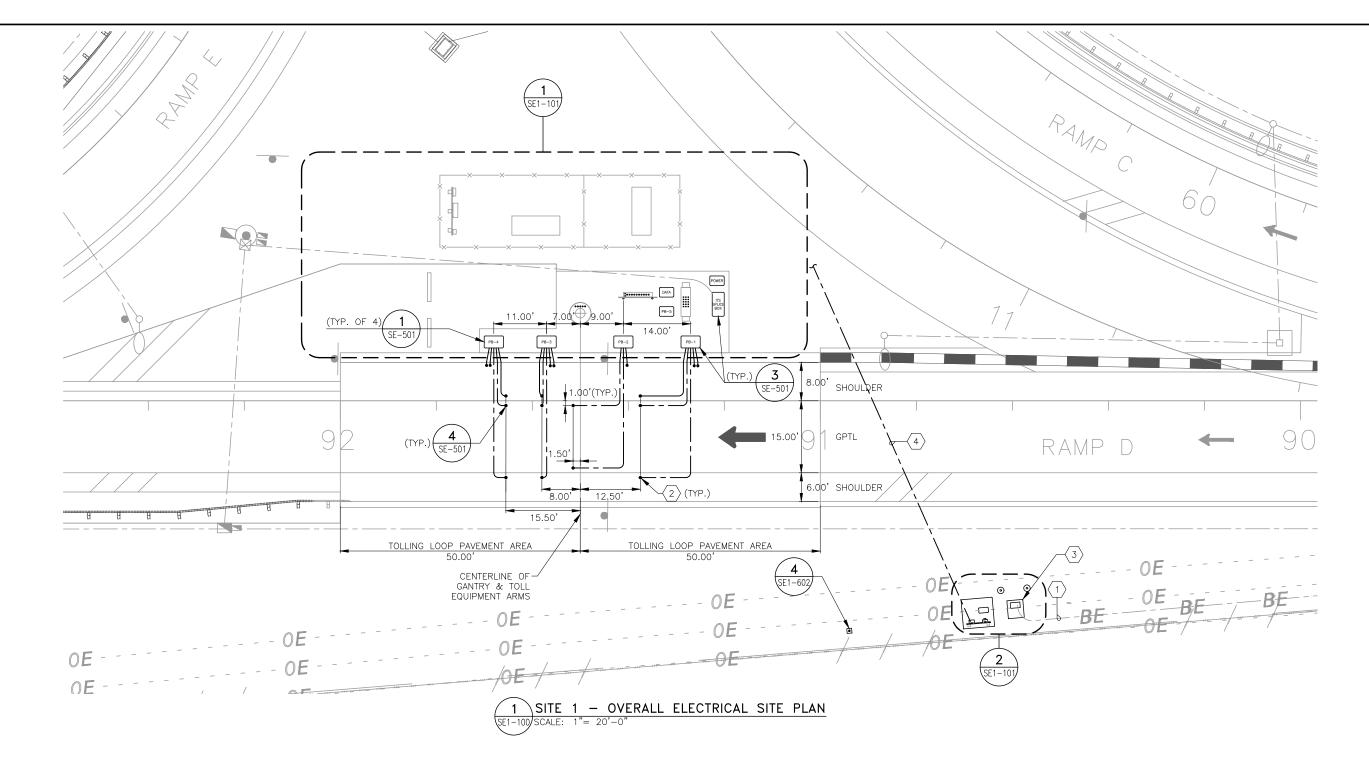- 1) BURIED PRIMARY CONDUIT AND CONDUCTORS BY POWER COMPANY. REFER TO UTILITY ADJUSTMENT SHEETS FOR CONTINUATION. THE ELECTRICAL CONTRACTOR SHALL CONTACT THE UTILITY COMPANY WITHIN TWO WEEKS OF NTP TO ENSURE ELECTRICAL SERVICE IS AVAILABLE WHEN CONSTRUCTION OF THE TOLL SITE IS COMPLETE. CONTACT MR. STEVE SZYMAKOWSKI AT TECO, (813) 625–3899. THE ELECTRICAL CONTRACTOR SHALL BE RESPONSIBLE FOR PAYING THE POWER COMPANY TO BRING POWER TO THE TRANSFORMER (PRIMARY). COORDINATE INSTALLATION WITH CIVIL, ROADWAY CONSTRUCTION AND POWER UTILITY COMPANY AS REQUIRED.
- 2 EXACT LOCATIONS OF ALL ROADWAY TOLLING LOOP LANE CONDUIT STUB-UPS MUST BE COORDINATED WITH T.E.C. TRANSCORE PRIOR TO ROUGH-IN. TOLLING LOOP LAYOUT (PROVIDED BY T.E.C. TRANSCORE) IS NOT SHOWN FOR
- PROPOSED LOCATION FOR UTILITY TRANSFORMER. FINAL TRANSFORMER LOCATION SHALL BE COORDINATED WITH UTILITY REPRESENTATIVE PRIOR TO CONDUIT ROUGH-IN, CONCRETE SLAB OR BOLLARD INSTALLATION. ELECTRICAL INSTALLATION AT TRANSFORMER LOCATION MUST BE INSPECTED AND APPROVED BY TECO.
- 4 UNDERGROUND FEEDER ROUTING, REFER TO DRAWING SE1-601. THE CONTRACTOR SHALL ROUTE FEEDER CONDUIT AROUND, BUT NOT UNDER, LARGE PIECES OF EQUIPMENT OR TOLLING LOOP PAVEMENT AREA. COORDINATE CONDUIT ROUTING WITH ALL UTILITIES, ROADWAY CONSTRUCTION AND ADJACENT CONSTRUCTION ACTIVITY AS REQUIRED. THE ELECTRICAL CONTRACTOR SHALL PAY FOR ALL COST ASSOCIATED WITH THE INSTALLATION OF THE ELECTRICAL SERVICE INCLUDING THE SERVICE DISCONNECTING MEANS, GROUNDING, METER SOCKET AND OTHER WORK AS SPECIFIED.

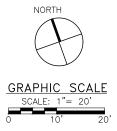

								RAMP D		
		REVISIONS				TAMPA HILLSBO	OROUGH	SHEET TITLE:	REF. DWG. NO	NO.
DATE	DESCRIPTION	DATE	DESCRIPTION	AECOM Technical Services, Inc.		EXPRESSWAY AU	THORITY	SITE 1 - OVERALL ELECTRICAL SITE PLAN	SE1-100	
				7650 West Courtney Campbell Causeway	ROAD NO.	COUNTY	THEA PROJECT NO.		351-100	
				Tampa, FL 33607-1462			FDOT FINANCIAL PROJECT II		SHEET NO.	ა.
				C.A. No. 8115	SR 600	HILLSBOROUGH	0-17-00217	SELMON WEST EXTENSION FROM THE GANDY BRIDGE TO THE WESTERN TERMINUS OF THE LEE ROY SELMON EXPRESSWAY		┨
				Pete Pastore, P.E. No. 77103	SR 618		439023-1-52-01	WESTERN TERMINUS OF THE LEE RUY SELMON EXPRESSWAY	12	




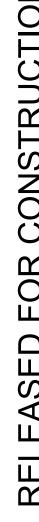



- $\langle 1 \rangle$ (3) 2" CONDUITS (TOLLING LOOPS).
- $\langle 2 \rangle$ (4) 2" CONDUITS (TOLLING LOOPS).
- TOLLING EQUIPMENT CONTROL CABINET, PROVIDED BY OTHERS. ALL CONDUIT STUB-UPS INTO THE CONTROL CABINET SLAB SHALL EXTEND 1" ABOVE SLAB, TERMINATED WITH A GROUNDING BUSHING. COORDINATE TOLLING EQUIPMENT CONTROL CABINET SIZE WITH THEA AND OBTAIN FINAL APPROVAL FROM THEA ON FINAL CABINET SIZE.
- $\left<4\right>$ (2) 2" CONDUITS (FIBER OPTIC CABLE FOR NETWORK CONNECTIONS).
- (2) 2" CONDUITS (FIBER OPTIC CABLE FOR NETWORK CONNECTIONS) TO BE INSTALLED BY ÌTŚ CONTRACTOR. REFER TO SITE AND ITS PLANS FOR CONTINUATIOŃ.
- 6 PROVIDE 13" X 24" X 18" DEEP POLYMER CONCRETE PULLBOX WITH COVER STAMPED "THEA ELECTRIC POWER". PULLBOX AND COVER SHALL BE MINIMUM UL LISTED, ANSI/SCTE 77 LOAD COMPLIANT AND ANSI TIER 15 RATED. REFER TO DRAWING SE1-601.
- (7) POWER CIRCUITING FROM GENERATOR CIRCUIT BREAKER TO ATS. REFER TO DRAWING
- $\begin{picture}(40,0)\put(0,0){\line(0,0){19}}\end{picture}$ (2) 1" CONDUITS FROM GENERATOR CONTROL PANEL TO TOLLING COMMUNICATIONS CABINET.
- PROVIDE 24" X 36" X 24" POLYMER CONCRETE PULLBOX WITH COVER STAMPED "THEA DATA". PULLBOX AND COVER SHALL BE MINIMUM UL LISTED, ANSI/SCTE 77 LOAD COMPLIANT AND ANSI TIER 15 RATED.
- (11) PROVIDE 30" X 60" X 36" POLYMER CONCRETE PULLBOX WITH COVER STAMPED "THEA ITS FIBER SPLICE BOX". PULLBOX AND COVER SHALL BE MINIMUM UL LISTED, ANSI/SCTE 77 LOAD COMPLIANT AND ANSI TIER 15 RATED.

- $\langle 12 \rangle$ 2 #14 (GENERATOR RUN), 4 #14 (SPARE), 1 #14 GROUND IN 1" CONDUIT.
- (13) LIQUEFIED PROPANE GAS FUEL TANK. REFER TO TSP.
- $\langle 14 \rangle$ (5) 3" CONDUITS (DATA).
- $\langle 15 \rangle$ (2) 2" CONDUITS (POWER). REFER TO DRAWING SE1-601.
- $\langle 16 \rangle$ (1) 3" POWER CONDUIT, (2) 3" DATA CONDUITS, (1) 3" (E6) CONDUIT, (1) 3"
- 2" CONDUIT ROUTED WITH FUEL PIPING. COORDINATE EXACT ROUTING WITH FUEL PIPING CONTRACTOR PRIOR TO ROUGH-IN.
- PROVIDE 24" X 36" X 24" POLYMER CONCRETE PULLBOX WITH COVER STAMPED "THEA POWER". PULLBOX AND COVER SHALL BE MINIMUM UL LISTED, ANSI/SCTE 77 LOAD COMPLIANT AND ANSI TIER 15 RATED.
- PROVIDE 24" X 36" X 24" POLYMER CONCRETE PULLBOX, OPEN BOTTOM WITH GASKET AND COVER STAMPED THEA TOLLING LOOPS". PULLBOX AND COVER SHALL BE MINIMUM UL LISTED, ANSI/SCTE 77 LOAD COMPLIANT, AND ANSI TIER 15
- 20 SECONDARY POWER SERVICE CONDUCTORS. REFER TO DRAWING SE1-601.
- (21) LIQUEFIED PROPANE GAS GENERATOR. REFER TO DRAWING SE1-601.
- 22 PROPOSED LOCATION FOR UTILITY TRANSFORMER.
- (23) POWER FEEDER CONDUCTORS. REFER TO DRAWING SE1-601

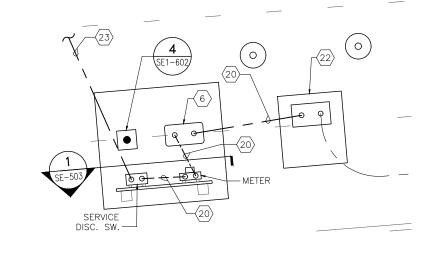

\SITE 1 - SERVICE POINT DETAILS SE1-101/SCALE: 1"= 5'-0"



SCALE: 1"= 10'

REF. DWG. NO

RAMP D

		REVISIONS		
DATE	DESCRIPTION	DATE	DESCRIPTION	AECOM Technical Services, In 7650 West Courtney Campbell Causeway Tampa, FL 33607-1462 C.A. No. 8115
				Pete Pastore, P.E. No. 77103


	TAMPA HILLSBO EXPRESSWAY AU		
ROAD NO.	COUNTY	THEA PROJECT NO. FDOT FINANCIAL PROJECT ID	PF
SR 600 SR 618	HILLSBOROUGH	<i>O-17-00217</i> 439023-1-52-01	

T TITLE						
	SITE	1 -	ENLARGED	ELECTRICAL	SITE	PLA
ECT NA	ME:					

SELMON WEST EXTENSION FROM THE GANDY BRIDGE TO THE

SE1-101 SHEET NO. WESTERN TERMINUS OF THE LEE ROY SELMON EXPRESSWAY 13

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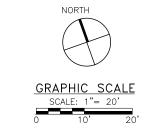
SE1-102/SCALE: 1"= 20'-0'

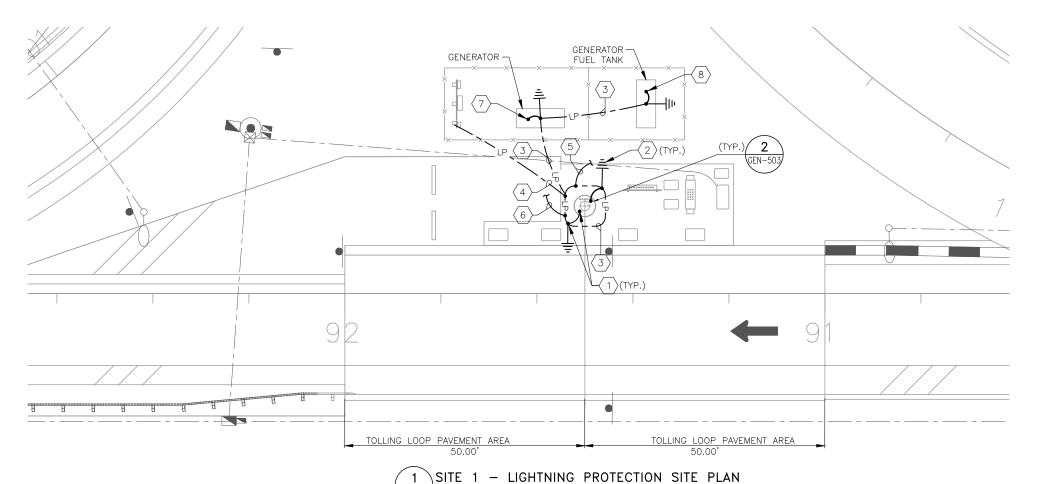GENERAL NOTES:

- 1. THIS SHEET DEPICTS THE LIGHTNING PROTECTION SYSTEM FOR THE GANTRY. ALL WORK SHALL MEET NFPA 780.
- 2. SEE TSP SECTION 26 41 13.

REFERENCE NOTES:

- 1 STRANDED COPPER LIGHTNING PROTECTION CONDUCTOR. BONDED TO GANTRY COLUMN AND TO GROUND RING ELECTRODE. REFER TO
- 2 20' LONG X 5/8" DIAMETER COPPER-CLAD STEEL GROUND ROD.
- BARE STRANDED COPPER CONDUCTOR, 36" BELOW FINISHED GRADE. DO NOT ROUTE CONDUCTOR UNDER TOLLING LOOP
- BOND POWER DISTRIBUTION SUPPORT STRUCTURE TO THE LIGHTNING PROTECTION GROUND RING ELECTRODE. REFER TO DRAWING GEN-503 AND SE1-602.
- BOND ALL METAL WIRE TROUGHS TO THE LIGHTNING PROTECTION GROUND RING ELECTRODE. REFER TO DRAWING GEN-503 AND
- 6 BOND ALL METAL FENCE POSTS TO THE LIGHTNING PROTECTION GROUND RING ELECTRODE. REFER TO DRAWING GEN-503 AND
- 7 BOND GENERATOR ENCLOSURE TO THE LIGHTNING PROTECTION GROUND RING ELECTRODE. REFER TO DRAWING GEN-503 AND SE1-602.
- $\langle 8 \rangle$ bond generator fuel tank to the lightning protection GROUND RING ELECTRODE. REFER TO DRAWING GEN-503 AND SE1-602.



REF. DWG. NO.

SE1-102

SHEET NO.

14

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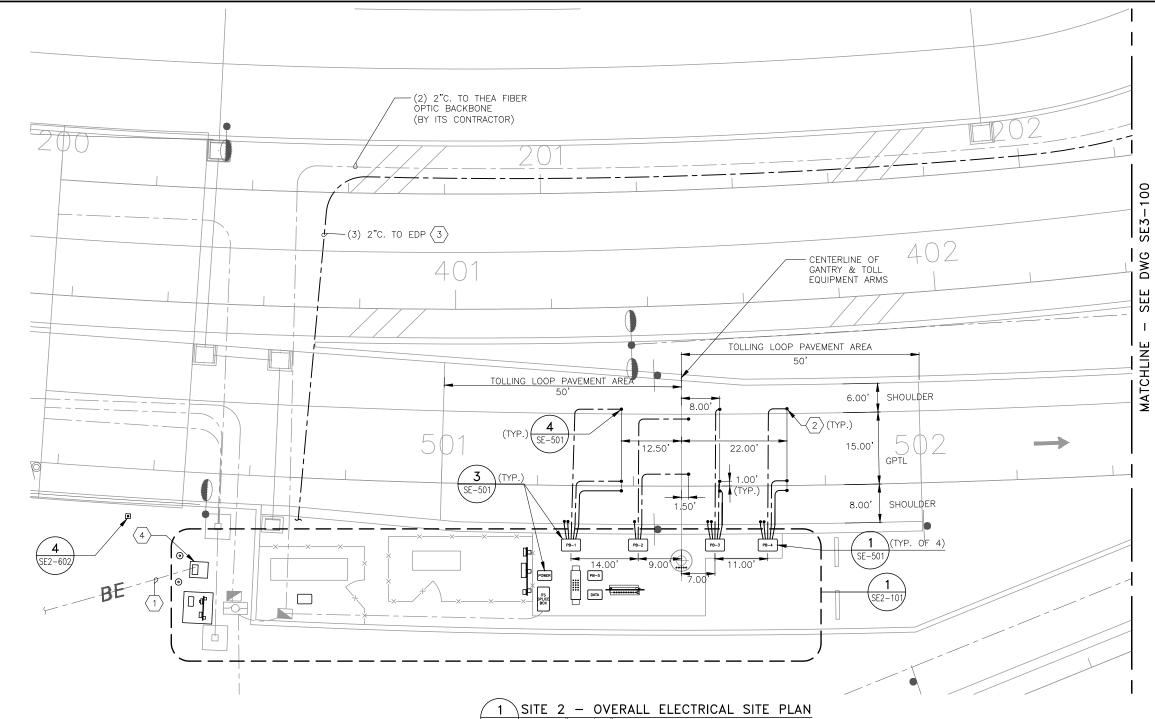
		REVISIONS		
DATE	DESCRIPTION	DATE	DESCRIPTION	AECOM Technical Services, 17650 West Courtney Campbell Causeway Tampa, FL 33607-1462 C.A. No. 8115 Pete Pastore, P.E. No. 7710

TAMPA HILLSBOROUGH EXPRESSWAY AUTHORITY THEA PRO. ROAD NO. COUNTY FDOT FINANCIA 0-17-0 SR 600 HILLSBOROUGH 439023-7103 SR 618

	SHEET TITLE:
	SIT
JECT NO.	
AL PROJECT ID	PROJECT NAME:
00217	SELMON
-1-52-01	WESTE

TE 1 - LIGHTNING PROTECTION SITE PLAN

N WEST EXTENSION FROM THE GANDY BRIDGE TO THE ERN TERMINUS OF THE LEE ROY SELMON EXPRESSWAY



- BURIED PRIMARY CONDUIT AND CONDUCTORS BY POWER COMPANY. REFER TO UTILITY ADJUSTMENT SHEETS FOR CONTINUATION. THE ELECTRICAL CONTRACTOR SHALL CONTACT THE UTILITY COMPANY WITHIN TWO WEEKS OF NTP TO ENSURE ELECTRICAL SERVICE IS AVAILABLE WHEN CONSTRUCTION OF THE TOLL SITE IS COMPLETE. CONTACT MR. STEVE SZYMAKOWSKI AT TECO, (813) 625-3899. THE ELECTRICAL CONTRACTOR SHALL BE RESPONSIBLE FOR PAYING THE POWER COMPANY TO BRING POWER TO THE TRANSFORMER (PRIMARY). COORDINATE INSTALLATION WITH CIVIL, ROADWAY CONSTRUCTION AND POWER UTILITY COMPANY AS REQUIRED.
- 2) EXACT LOCATIONS OF ALL ROADWAY TOLLING LOOP LANE CONDUIT STUB-UPS MUST BE COORDINATED WITH T.E.C. TRANSCORE PRIOR TO ROUGH-IN. TOLLING LOOP LAYOUT (PROVIDED BY T.E.C. TRANSCORE) NOT SHOWN FOR CLARITY.
- (3) CAREFULLY COORDINATE INSTALLATION WITH ROADWAY CONSTRUCTION.
 REFER TO SE2-601 FOR POWER CONDUIT AND CONDUCTOR DETAILS.

PROPOSED LOCATION FOR UTILITY TRANSFORMER. FINAL TRANSFORMER LOCATION SHALL BE COORDINATED WITH UTILITY REPRESENTATIVE PRIOR TO CONDUIT ROUGH—IN, CONCRETE SLAB OR BOLLARD INSTALLATION. ELECTRICAL INSTALLATION AT TRANSFORMER LOCATION MUST BE INSPECTED


SCALE: 1"= 20'-0'

AND APPROVED BY TECO.

GRAPHIC SCALE

SCALE: 1"= 20'


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		REVISIONS				TAMPA HILLSBO	PROUGH	SHEET TITLE:	REF. DWG. NO	
DATE	DESCRIPTION	DATE	DESCRIPTION	AECOM Technical Services, Inc.	EXPRESSWAY AUTHORITY		THORITY	SITE 2 - OVERALL ELECTRICAL SITE PLAN	SE2-100	
				7650 West Courtney Campbell Causeway Tampa, FL 33607-1462	ROAD NO.	COUNTY	THEA PROJECT NO.		3E2-100	
					Tampa, FL 33607-1462		FDOT FINANCIAL PROJECT II O-17-00217	SELMON WEST EXTENSION FROM THE GANDY BRIDGE TO THE	SHEET NO.	
		C.A. No. 8115 Pete Pastore, P.E. No. 77103	SR 600 SR 618	HILLSBOROUGH	439023-1-52-01	WESTERN TERMINUS OF THE LEE ROY SELMON EXPRESSWAY	15			
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- $\langle 1 \rangle$ (3) 2" CONDUITS (TOLLING LOOPS).
- $\langle 2 \rangle$ (4) 2" CONDUITS (TOLLING LOOPS).
- TOLLING EQUIPMENT CONTROL CABINET, PROVIDED BY OTHERS. ALL CONDUIT STUB-UPS INTO THE CONTROL CABINET SLAB SHALL EXTEND 1" ABOVE SLAB, TERMINATED WITH A GROUNDING BUSHING. COORDINATE TOLLING EQUIPMENT CONTROL CABINET SIZE WITH THEA AND OBTAIN FINAL APPROVAL FROM THEA ON FINAL CABINET SIZE.
- $\langle 4 \rangle$ (2) 2" CONDUITS (FIBER OPTIC CABLE FOR NETWORK CONNECTIONS).
- (2) 2" CONDUITS (FIBER OPTIC CABLE FOR NETWORK CONNECTIONS) TO BE INSTALLED BY ITS CONTRACTOR. REFER TO SITE AND ITS PLANS FOR CONTINUATION.
- 6 PROVIDE 13" X 24" X 18" DEEP POLYMER CONCRETE PULLBOX WITH COVER STAMPED "ELECTRIC POWER". PULLBOX AND COVER SHALL BE MINIMUM UL LISTED, ANSI/SCTE 77 LOAD COMPLIANT AND ANSI TIER 15 RATED. REFER TO DRAWING SE2-601.
- $\fbox{7}$ POWER CIRCUITING FROM GENERATOR CIRCUIT BREAKER TO ATS. REFER TO DRAWING SE2-601.
- (8) (2) 1" CONDUITS FOR JACKET WATER HEATER AND BATTERY CHARGER CIRCUITING. REFER TO DRAWING SE2-601.
- $\boxed{9}$ (2) 1" CONDUITS FROM GENERATOR CONTROL PANEL TO TOLLING COMMUNICATIONS CABINET.
- PROVIDE 24" X 36" X 24" POLYMER CONCRETE PULLBOX WITH COVER STAMPED "THEA DATA". PULLBOX AND COVER SHALL BE MINIMUM UL LISTED, ANSI/SCTE 77 LOAD COMPLIANT AND ANSI TIER 15 RATED.
- PROVIDE 30" X 60" X 36" POLYMER CONCRETE PULLBOX WITH COVER STAMPED "THEA ITS FIBER SPLICE BOX". PULLBOX AND COVER SHALL BE MINIMUM UL LISTED, ANSI/SCTE 77 LOAD COMPLIANT AND ANSI TIER 15 RATED.

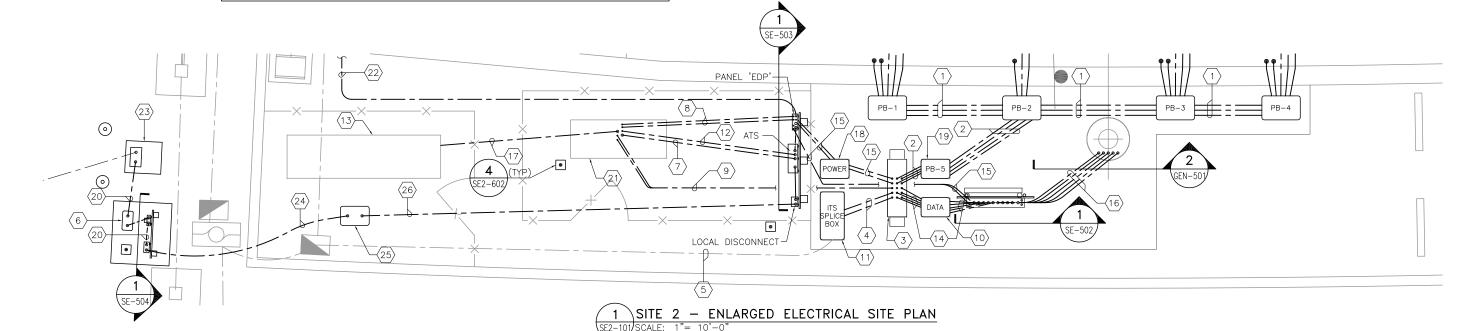- $\langle 12 \rangle$ 2 #14 (GENERATOR RUN), 4 #14 (SPARE), 1 #14 GROUND IN 1" CONDUIT.
- (13) LIQUEFIED PROPANE GAS FUEL TANK. REFER TO TSP.
- $\langle 14 \rangle$ (5) 3" CONDUITS (DATA).
- $\langle 15 \rangle$ (2) 2" CONDUITS (POWER). REFER TO DRAWING SE2-601.
- (16) (1) 3" POWER CONDUIT, (2) 3" DATA CONDUITS, (1) 3" (E6) CONDUIT, (1) 3" SPARE CONDUIT.
- 2" CONDUIT ROUTED WITH FUEL PIPING. COORDINATE EXACT ROUTING WITH FUEL PIPING CONTRACTOR PRIOR TO ROUGH—IN.
- PROVIDE 24" X 36" X 24" POLYMER CONCRETE PULLBOX WITH COVER STAMPED THEA POWER". PULLBOX AND COVER SHALL BE MINIMUM UL LISTED, ANSI/SCTE 77 LOAD COMPLIANT AND ANSI TIER 15 RATED.
- 19) PROVIDE 24" X 36" X 24" POLYMER CONCRETE PULLBOX, OPEN BOTTOM WITH GASKET AND COVER STAMPED "THEA TOLLING LOOPS". PULLBOX AND COVER SHALL BE MINIMUM UL LISTED, ANSI/SCTE 77 LOAD COMPLIANT, AND ANSI TIER
- (20) SECONDARY POWER SERVICE CONDUCTORS. REFER TO DRAWING SE2-601.
- (21) LIQUEFIED PROPANE GAS GENERATOR. REFER TO DRAWING SE2-601.
- (22) (3) 2" CONDUITS ROUTED FROM PANEL 'EDP' (SITE #2) TO POWER PULLBOX (SITE #3). ROUTE ADJACENT TO ITS CONDUIT AND LP SYSTEM CONDUCTOR. CAREFULLY COORDINATE INSTALLATION WITH ROADWAY CONSTRUCTION. REFER TO DRAWING SE2_601
- (23) PROPOSED LOCATION FOR UTILITY TRANSFORMER.

- UNDERGROUND FEEDER ROUTING, REFER TO DRAWING SE2-601. THE CONTRACTOR SHALL ROUTE FEEDER CONDUIT VERTICALLY WITHIN MSE WALL. ROUTE CONDUIT AROUND, BUT NOT UNDER, LARGE PIECES OF EQUIPMENT OR TOLLING LOOP PAVEMENT AREA. COORDINATE CONDUIT ROUTING WITH ALL UTILITIES, ROADWAY CONSTRUCTION AND ADJACENT CONSTRUCTION AS REQUIRED. THE ELECTRICAL CONTRACTOR SHALL PAY FOR ALL COSTS ASSOCIATED WITH THE ELECTRICAL SERVICE INCLUDING THE SERVICE DISCONNECTING MEANS, GROUNDING, METER SOCKET AND OTHER WORK AS SPECIFIED.
- PROVIDE 24" X 36" X 24" POLYMER CONCRETE PULLBOX WITH COVER STAMPED THEA POWER". PULLBOX AND COVER SHALL BE MINIMUM UL LISTED, ANSI/SCTE 77 LOAD COMPLIANT AND ANSI TIER 15 RATED. PROVIDE VERTICAL STRAIN RELIEF DEVICE FOR CONDUCTORS, KELLEMS GRIP OR APPROVED EQUAL.
- $\langle 26 \rangle$ POWER FEEDER CONDUCTORS. REFER TO DRAWING SE2-601.



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REVISIONS				TAMPA HILLSBOROUGH		SHEET TITLE:				
DATE	DESCRIPTION	DATE	DESCRIPTION	AECOM Technical Services, Inc.	EXPRESSWAY AUTHORITY		THORITY	SITE 2 - ENLARGED ELECTRICAL SITE PLAN	SE 2-101	1
				7650 West Courtney Campbell Causeway Tampa, FL 33607-1462	ROAD NO.	COUNTY	THEA PROJECT NO.		JL2-101	┙
					60.600		FDOT FINANCIAL PROJECT II O-17-00217	SELMON WEST EXTENSION FROM THE GANDY BRIDGE TO THE	SHEET NO.	-
		C.A. No. 8115 Pete Pastore, P.E. No. 77103	SR 600 SR 618	HILLSBOROUGH	439023-1-52-01	WESTERN TERMINUS OF THE LEE ROY SELMON EXPRESSWAY	16	П		
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GENERAL NOTES:

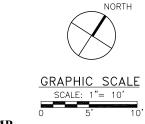- 1. THIS SHEET DEPICTS THE LIGHTNING PROTECTION SYSTEM FOR THE GANTRY. ALL WORK SHALL MEET NFPA 780.
- 2. SEE TSP SECTION 26 41 13.

DWG

- 1) STRANDED COPPER LIGHTNING PROTECTION CONDUCTOR. BONDED TO GANTRY COLUMN AND TO GROUND RING ELECTRODE. REFER TO DRAWING GEN-503.
- $\langle 2 \rangle$ 40' LONG X 5/8" DIAMETER COPPER-CLAD STEEL GROUND ROD.
- BARE STRANDED COPPER CONDUCTOR, 36" BELOW FINISHED GRADE. DO NOT ROUTE CONDUCTOR UNDER TOLLING LOOP PAVEMENT. CAREFULLY COORDINATE INSTALLATION WITH ROADWAY
- BOND ALL METAL WIRE TROUGHS TO THE LIGHTNING PROTECTION GROUND RING ELECTRODE. REFER TO DRAWING GEN-503 AND SE2-602.
- 5 BOND POWER DISTRIBUTION SUPPORT STRUCTURE TO THE LIGHTNING PROTECTION GROUND RING ELECTRODE. REFER TO DRAWING GEN-503 AND SE2-602.
- 6 BOND ALL METAL FENCE POSTS TO THE LIGHTNING PROTECTION GROUND RING ELECTRODE. REFER TO DRAWING GEN-503 AND
- (7) BOND GENERATOR ENCLOSURE TO THE LIGHTNING PROTECTION GROUND RING ELECTRODE. REFER TO DRAWING GEN-503 AND SE2-602.
- 8 BOND GENERATOR FUEL TANK TO THE LIGHTNING PROTECTION GROUND RING ELECTRODE. REFER TO DRAWING GEN-503 AND

REFERENCE NOTES:



TOLLING LOOP PAVEMENT AREA

GRAPHIC SCALE

NORTH

REF. DWG. NO.

SE2-102

SHEET NO.

17

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		REVISIONS		
DATE	DESCRIPTION	DATE	DESCRIPTION	AECOM Technical Services, In 7650 West Courtney Campbell Causeway Tampa, FL 33607-1462 C.A. No. 8115 Pete Pastore, P.E. No. 77103

401

 $-\sqrt{3}$ (TYP.)

GENERATOR

GENERATOR -

FUEL TANK

TAMPA HILLSBOROUGH EXPRESSWAY AUTHORITY ROAD NO. SR 600 HILLSBOROUGH SR 618


TOLLING LOOP PAVEMENT AREA

(2)(TYP.)

THEA PROJECT NO FDOT FINANCIAL PROJECT I O-17-00217 439023-1-52-01

SITE 2 - LIGHTNING PROTECTION SITE PLAN

SELMON WEST EXTENSION FROM THE GANDY BRIDGE TO THE WESTERN TERMINUS OF THE LEE ROY SELMON EXPRESSWAY

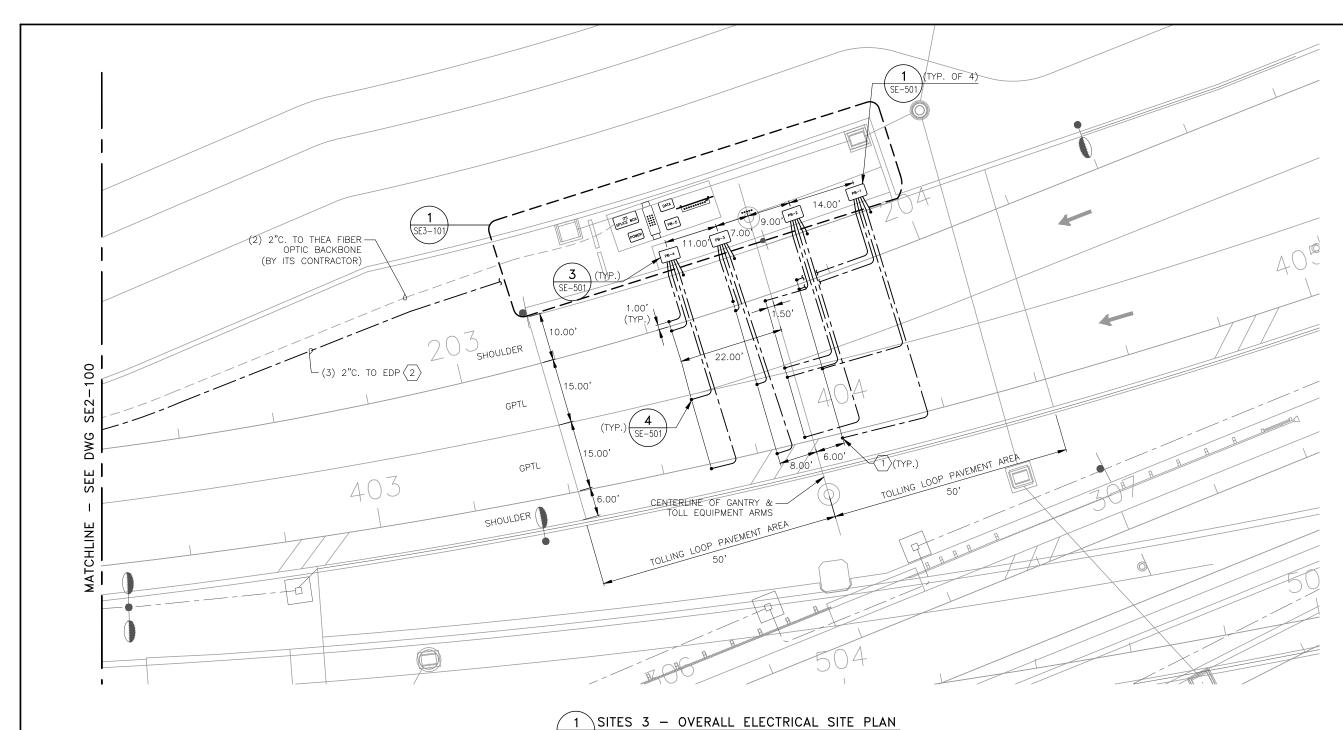

(1) EXACT LOCATIONS OF ALL ROADWAY TOLLING LOOP LANE CONDUIT STUB-UPS MUST BE COORDINATED WITH T.E.C. TRANSCORE PRIOR TO ROUGH-IN. TOLLING LOOP LAYOUT (PROVIDED BY T.E.C. TRANSCORE) NOT SHOWN FOR CLARITY.


2 CAREFULLY COORDINATE INSTALLATION WITH ROADWAY CONSTRUCTION.

	NORTH
i c	GRAPHIC SCALE SCALE: 1"= 20'
SELMON SB RAMP/RAMP F	

								SELMON SB KAMI /KAMI I	
	REVISIONS			TAMPA HILLSBOROUGH			SHEET TITLE:		
DATE	DESCRIPTION	DATE	DESCRIPTION	AECOM Technical Services, Inc.	EXPRESSWAY AUTHORITY		THORITY	SITE 3 - OVERALL ELECTRICAL SITE PLAN	SE3-100
				Tampa, FL 33607-1462	ROAD NO.	COUNTY	THEA PROJECT NO. FDOT FINANCIAL PROJECT ID	PROJECT NAME:	323-100
					CD 600		0-17-00217	SELMON WEST EXTENSION FROM THE GANDY BRIDGE TO THE	SHEET NO.
				Pete Pastore, P.E. No. 77103	SR 600 SR 618	HILLSBOROUGH	439023-1-52-01	WESTERN TERMINUS OF THE LEE ROY SELMON EXPRESSWAY	18

- $\left\langle 1 \right\rangle$ (3) 2" CONDUITS (TOLLING LOOPS).
- (4) 2" CONDUITS (TOLLING LOOPS).
- TOLLING EQUIPMENT CONTROL CABINET, PROVIDED BY OTHERS. ALL CONDUIT STUB-UPS INTO THE CONTROL CABINET SLAB SHALL EXTEND 1" ABOVE SLAB, TERMINATED WITH A GROUNDING BUSHING. COORDINATE TOLLING EQUIPMENT CONTROL CABINET SIZE WITH THEA AND OBTAIN FINAL APPROVAL FROM THEA ON FINAL CABINET SIZE.
- $\left<4\right>$ (2) 2" CONDUITS (FIBER OPTIC CABLE FOR NETWORK CONNECTIONS).
- (2) 2" CONDUITS (FIBER OPTIC CABLE FOR NETWORK CONNECTIONS) TO BE INSTALLED BY ITS CONTRACTOR. REFER TO SITE AND ITS PLANS FOR CONTINUATION.
- $\fbox{6}$ (3) 2" CONDUITS (POWER) ROUTED FROM SITE #2, PANEL 'EDP'. ROUTE CONDUITS ADJACENT TO ITS CONDUIT AND LIGHTNING PROTECTION SYSTEM CONDUCTOR. REFER TO DRAWING SE2-601.
- $\left\langle 7 \right\rangle$ (2) 2" CONDUITS (POWER). REFER TO DRAWING SE2-601.
- PROVIDE 24" X 36" X 24" POLYMER CONCRETE PULLBOX WITH COVER STAMPED "DATA". PULLBOX AND COVER SHALL BE MINIMUM UL LISTED, ANSI/SCTE 77 LOAD COMPLIANT AND ANSI TIER 15 RATED.

- 9 PROVIDE 30" X 60" X 36" POLYMER CONCRETE PULLBOX WITH COVER STAMPED "ITS FIBER SPLICE BOX". PULLBOX AND COVER SHALL BE MINIMUM UL LISTED, ANSI/SCTE 77 LOAD COMPLIANT AND ANSI TIER 15 RATED.
- PROVIDE 24" X 36" X 24" POLYMER CONCRETE PULLBOX WITH COVER STAMPED "POWER". PULLBOX AND COVER SHALL BE MINIMUM UL LISTED, ANSI/SCTE 77 LOAD COMPLIANT AND ANSI TIER 15 RATED.
- PROVIDE 24" X 36" X 24" POLYMER CONCRETE PULLBOX, OPEN BOTTOM WITH GASKET AND COVER STAMPED "TOLLING LOOPS". PULLBOX AND COVER SHALL BE MINIMUM UL LISTED, ANSI/SCTE 77 LOAD COMPLIANT, AND ANSI TIER 15 RATED.
- $\langle 12 \rangle$ (5) 3" CONDUITS (DATA).
- (13) (1) 3" POWER CONDUIT, (2) 3" DATA CONDUITS, (1) 3" E6 CONDUIT, (1) 3" SPARE CONDUIT.

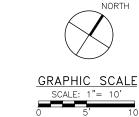

SELMON SB RAMP/RAMP F

DATE	DESCRIPTION	REVISIONS	S ATF	DESCRIPTION			TAMPA HILLSBOROUGH EXPRESSWAY AUTHORITY		SHEET TITLE:	
27.11.2	BESCHITTON	,		2200	7650 West Courtney Campbell Causeway	ROAD NO.	THEA PROJECT NO		SITE 3 - ENLARGED ELECTRICAL SITE PLAN	
					Tampa, FL 33607-1462	SR 600	HILLSBOROUGH		SELMON WEST EXTENSION FROM THE GANDY BRIDGE TO THE	SHEET NO.
					Pete Pastore, P.E. No. 77103	SR 618	THEESBOROOGH	439023-1-52-01	WESTERN TERMINUS OF THE LEE ROY SELMON EXPRESSWAY s\Toll Gantry\THEA\439023 - SELMON WEST EXTENSION\Drawings\SE3-101.dwg 06/21/2018 13:36	19

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GENERAL NOTES: 1. THIS SHEET DEPICTS THE LIGHTNING PROTECTION SYSTEM FOR THE GANTRY. ALL WORK SHALL MEET NFPA 780. 2. SEE TSP SECTION 26 41 13.

REFERENCE NOTES:

- STRANDED COPPER LIGHTNING PROTECTION CONDUCTOR. BONDED TO GANTRY COLUMN AND TO GROUND RING ELECTRODE. REFER TO DRAWING GEN-503.
- $\langle 2 \rangle$ 40' LONG X 5/8" DIAMETER COPPER-CLAD STEEL GROUND ROD.
- BARE STRANDED COPPER CONDUCTOR, 36" BELOW FINISHED GRADE. DO NOT ROUTE CONDUCTOR UNDER TOLLING LOOP PAYEMENT. CAREFULLY COORDINATE INSTALLATION WITH ROADWAY CONSTRUCTION.
- BOND ALL METAL WIRE TROUGHS TO THE LIGHTNING PROTECTION GROUND RING ELECTRODE. REFER TO DRAWING GEN-503 AND SE2-602.

1 SITE 3 - LIGHTNING PROTECTION SITE PLAN
SE3-102 SCALE: 1"= 20'-0"

NORTH GRAPHIC SCALE

SCALE: 1"= 20' SELMON SB RAMP/RAMP F

AECOM Technical Services, Inc 7650 West Courtney Campbell Causeway Tampa, FL 33607-1462 C.A. No. 8115 Pete Pastore, P.E. No. 77103	DESCRIPTION	DATE	DESCRIPTION	DATE	
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Causeway L 33607-1462	ROAL
No. 8115 e, P.E. No. 77103	SR (SR

	TAMPA HILLSBO EXPRESSWAY AU		SHI
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HEET TITL	.E:									
	SITE	3 -	LIGHT	TNING	PRC	TEC	TION	SITE	PLAI	V
ROJECT N	IAME:									
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WE	STERN	TER	MINUS	OF TH	IE LEE	ROY	SELMO	ON EXP	RESSI	VAY

REF. DWG. NO. SITE PLAN SE3-102 SHEET NO. BRIDGE TO THE 20